DOOR SCHEDULE:

DOOR TYPE							FRAME		REMARKS
No.	W	H	T	MAT.	TYPE	GLASS	МДТ.	DET.	
ØI	3'-0"	8'-0"	1 3/4"	MTL	ALMTL DR	-	WD		MTL. THRESHOLD WEATHER STRIP, (IMPACT-RESISTANT)
Ø 2	6'-0"	7'-Ø"	1 3/4"	AL	AL/CAT II GL SLIDING	IMPACT	AL		DESIGNATED EMERGENCY MEANS OF ESCAPE AS PER FBC 2017 SECTION R311.4.1 & R311.4.2 WEATHER STRIP/THRESHOLD MAX 1 ½" STEP GLAZ "U" = 1,08, SHGC = 0.50
Ø3	3'-Ø"	6'-8"	1 3/8"	WD.	RAISED PANEL, SWING		WD.		
Ø4	2'-8"	6'-8"	1 3/8"	WD.	RAISED PANEL, SWING		WD.		MARBLE SADDLE AT BATHROOMS ONLY
Ø5	2'-6"	6'-8"	1 3/8"	WD.	RAISED PANEL, SWING		WD.		MARBLE SADDLE AT BATHROOMS ONLY
06	4'-0"	6'-8"		WD.	SLIDING CLOSET		WD.		CLOSETS
ØT	2'-6"	6'-8"		WD.	COLONIAL BI-FOLD		ALUM.		A/C METAL DOOR , FULL LOUVERED
Ø8	2'-Ø"	6'-8"		WD.	POCKET DOOR		WD.		
09	3'-Ø"	6'-8"		WD.	SLIDING CLOSET		WD.		CLOSETS
10	2'-6"	6'-8"	1 3/8"	WD	BI-FOLD COLONIAL		WD.		
11	2'-6"	6'-8"		WD.	POCKET DOOR		WD.		
12	7'-Ø"	7'-Ø"	1 3/4"	AL	AL/CAT II GL SLIDING	IMPACT	AL		DESIGNATED EMERGENCY MEANS OF ESCAPE AS PER FBC 2017 SECTION R311.4.1 & R311.4.2 WEATHER STRIP/THRESHOLD MAX 1 ½ STEP GLAZ "U" = 1,08, SHGC = 0.50

GENERAL NOTES:

- 1. BATHROOM FLOORS AND BASE TO BE OF IMPERVIOUS MATERIAL AS PER F.B.C. 2020 SHOWER COMPARTMENTS SHALL HAVE FLOORS AND WALLS CONSTRUCTED OF SMOOTH, CORROSION RESISTANT AND
- NONABSORBENT WATER-RESISTANT MATERIALS TO A HEIGHT OF NOT LESS THAN 12 INCHES ABOVE THE COMPARTMENT FLOOR AT THE DRAIN AS PER SECTION R 301.2 F.B.C. 2020 8. ALL WINDOWS, DOORS, GLASS AND GLAZING 2. FLORIDA BUILDING CODE R 310
- AN OUTSIDE WINDOW OR DOOR OPERABLE FROM THE INSIDE WITHOUT THE USE OF TOOLS, KEYS, OR SPECIAL EFFORT AND 9. CAT. II SAFETY GLASS SHALL BE USED AT ALL SHOWER/TUB IN WIDTH, 24 INCHES IN HEIGHT, AND 5.7 SQ. FT. IN AREA. THE BOTTOM OF THE OPENING SHALL NOT BE MORE THAN 44" ABOVE THE FLOOR.
- 3. NUMBERS OF ADDRESS SHALL BE PLACED VISIBLE AND LEGIBLE FROM THE STREET FRONTING THE PROPERTY AND SHALL BE 3 INCHES MIN. IN HEIGHT.
- 4. TOILET ROOMS SHALL COMPLY WITH SECT. R307.1 F.B.C. 2020
- 6. ALL FIXED GLASS PANELS SHALL BE 3/16" SAFETY GLASS.
- 7. CLOSET AND BATHROOM DOORS
- EVERY CLOSET DOOR LATCH SHALL BE SUCH THAT CHILDREN CAN OPEN THE DOOR FROM INSIDE THE CLOSET.
- EVERY BATHROOM DOOR SHALL BE DESIGN TO ALLOW OPENING FROM THE OUTSIDE DURING AN EMERGENCY WHEN LOCKED.
- DOORS MAY BE SWINGING OR SLIDING.
- FLOOR PLAN LEGEND:
- A REFRIGERATOR SPACE B DOUBLE SINK WITH DISPOSAL
- C DISHWASHER
- P SLIDE-IN RANGE AND OVEN
- E LINE OF CABINETS ABOVE F 36" HIGH KITCHEN COUNTER
- WASHER AND DRYER SPACE
- H ELECTRIC WATER HEATER
- I AIR HANDLER UNIT A/C CONDENSING UNIT(SLAB 3'-0"X 7'-6") J ELEV +16.5Ø' NGVD
- K CLOSET W/ SHELVES
- L 22" × 36" ATTIC ACCESS PANEL
- M 42" HIGH COUNTER TOP
- N CAT II SHOWER DOOR
- O ELECT. PANEL, SURFACE MOUNTED
- P GALY STEEL COL SEE STRUCT
- 42" HGT. GUARD RAIL MEASURED FROM BOTTOM OF TREAD TO REJECT 4" DIA OBJECT
- R 42" HT GUARDRAIL (36" HANDRAIL) 6 ALUM SPIRAL STAIR PROVIDE SHOP DRAWINGS
- † 42" ALUMINUM RAILING ON CONC CURB

- NO DOOR IN ANY MEANS OF ESCAPE SHALL BE LOCKED AGAINST EGRESS WHEN THE BUILDING IS OCCUPIED. ALL DEVICES THAT IMPEDE OR PROHIBIT EGRESS OR THAT CANNOT BE EASILY DISENGAGED SHALL BE PROHIBITED.
- ARE TO COMPLY WITH HIGH VELOCITY HURRICANE ZONES R4410.2 FBC 2020
- PROVIDING A CLEAR OPENING OF NOT LESS THAN 20 INCHES
 IN WIDTH 24 INCHES IN HEIGHT. AND 5.7 SQ. FT. IN AREA.

 ENCLOSURES INCLUDING ANY GLAZING WITHIN 60" OF THE
 FINISH FLOOR SURFACE IN WALLS SURROUNDING ANY TUB OR SHOWER ENCLOSURE AS PER R4410.2.6.2 FBC 2020
 - 10. ATTIC ACCESS SHALL COMPLY WITH R807.1 FBC 2020 AS SET FORTH BELOW:
- ATTIC ACCESS IN COMBUSTIBLE CEILING OR ROOF CONSTRUCTION, AND ATTIC ACCESS OPENING SHALL BE PROVIDED TO ATTIC AREAS THAT EXCEED 30 S.F. AND HAVE A VERTICAL HEIGHT OF 30 INCHES OR GREATER 5. FOR COLUMN AND CONCRETE FILLED BLOCK CELL LOCATION, THE ROUGH-FRAMED OPENING SHALL NOT BE LESS SIZE & REINFORCING REFER TO FOUNDATION PLAN SHEET S-1 THAN 22 INCHES BY 30 INCHES ANS SHALL BE LOCATED IN HALLWAY OR OTHER ACCESSIBLE LOCATION. A 30- INCH MINIMUM UNOBSTRUCTED HEADROOM IN THE ATTIC SPACE SHALL BE PROVIDED
 - WALL AND CEILING FINISHES SHALL HAVE A FLAME SPREAD CLASSIFICATION OF NOT GREATER THAN 200 TESTED IN ACCORDANCE WITH ASTM E 84 PER FBC 2017 R 302.9.1 AND A SMOKE DEVELOPED INDEX OF NOT GREATER THAN 450 TESTED IN ACCORDANCE WITH ASTM E 84 PER FBC 2020 R 302.9.2
 - 12. ALL INSULATION MATERIALS SHALLL HAVE A FLAME-SPREAD INDEX OF NOT MORE THAN 25 AND A SMOKE-DEVELOPED INDEX OF NOT MORE THAN 450

AREA TABULATIONS

AT SOME POINT


GROUND FLOOR STORAGE	22 <i>0.</i> 9 SQ. FT.
ELEVATOR AND LOBBY	76.1 SQ. FT.
TOTAL ENCLOSED GROUND FLOOR	297 SQ. FT.
COVERED PARKING:	625.00 SQ. FT.
SECOND FLOOR A/C SPACE:	899.00 SQ. FT.
BALCONY:	150.00 SQ. FT.
THIRD FLOOR A/C SPACE:	832.00 SQ. FT.
BALCONY	83.00 SQ. FT.

WALL LEGEND


- INDICATES 8"x8"x16" MASONRY UNITS (SEE SHEET C-1 FOR FILLED CELL LOCATIONS)

FBC 2020 RESIDENTIAL CODE NEC 2017

TYPE OF CONSTRUCTION: VB OCCUPANCY: R-3

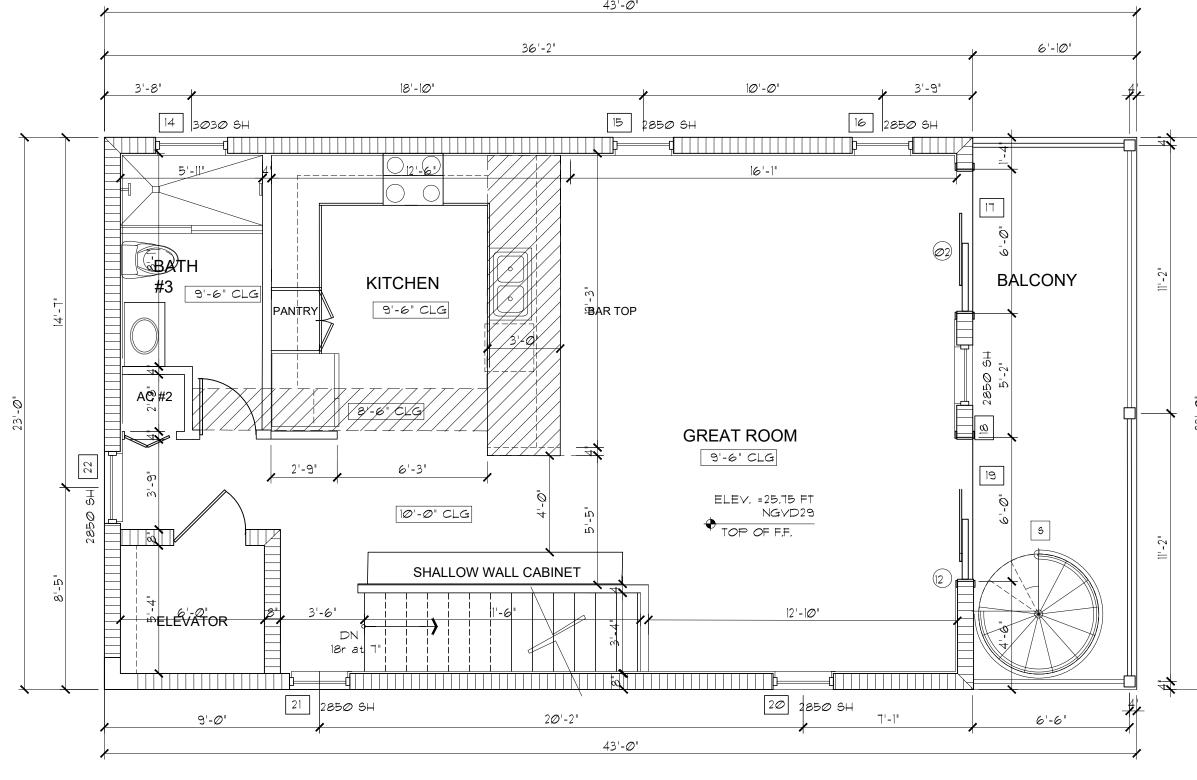



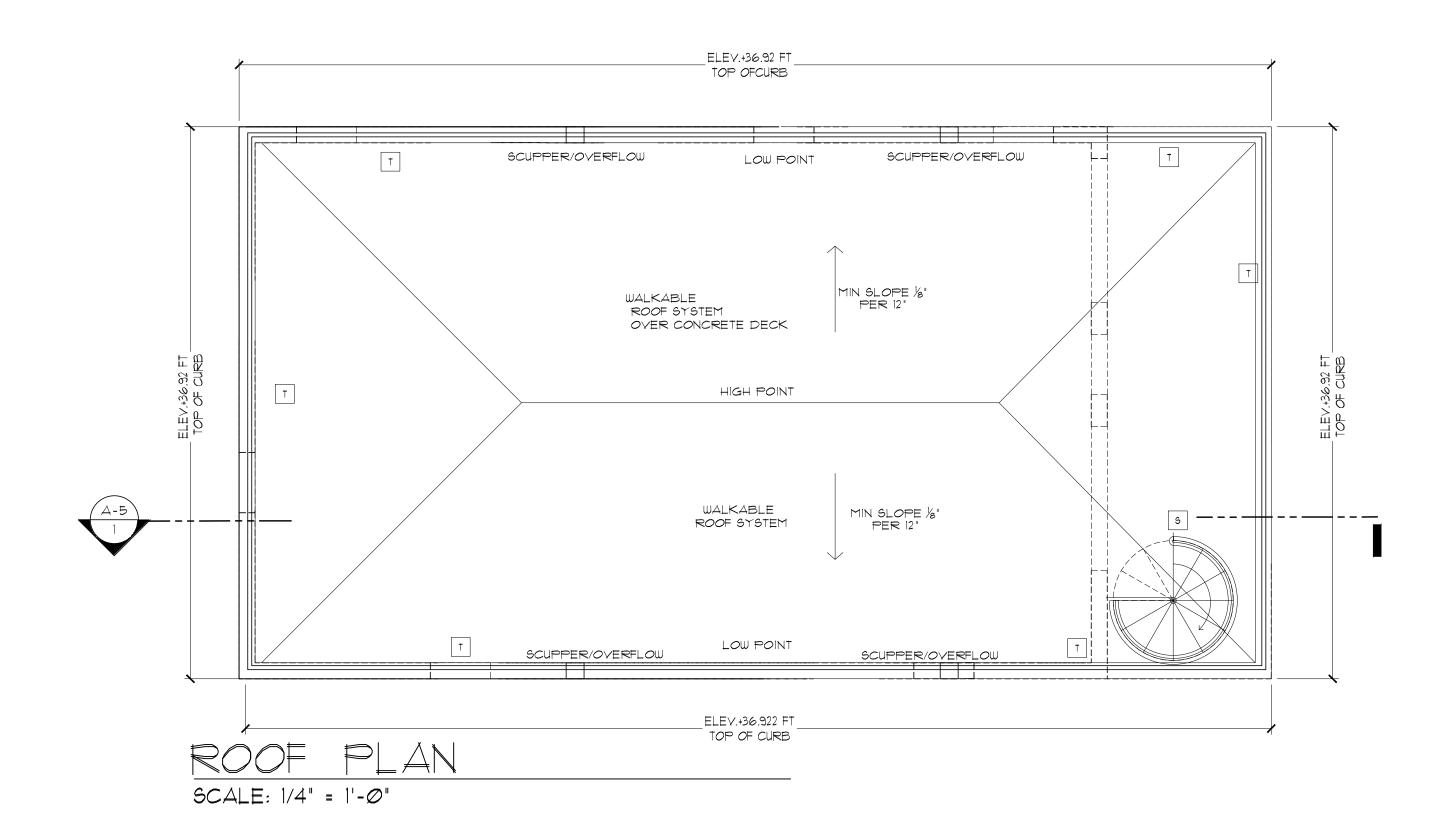



ORESTES LOPEZ-RECIO AR0009350

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FOR AE E POINT L HOH **FAMILY** SINGLE

SEAL

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REVISIONS: REV 1 10.06.22

DATE: Ø1-18-22 SCALE: AS SHOWN DRAWN: OLR

A-2

SHEET NO.: 1 OF

JOB NO.: 21-1128